

LEGEND:

- EXISTING CONSTRUCTION TO REMAIN.
- NEW FULL HEIGHT PARTITION. SEE DETAIL $\frac{6}{A-4}$
- EXISTING WIRE-MESH PARTITION TO REMAIN.

- $\frac{4}{A-4}$ PROVIDE "COR-COTE HCR" HIGH CHEMICAL RESISTANT NOVOLAC EPOXY COATING DISTRIBUTED BY GENERAL POLYMERS, (818) 365-9261 OR (800) 624-5041. WEBSITE: www.generalpolymers.com. PREPARE AREA AND APPLY COATING PER MANUFACTURER'S SPECIFICATIONS. FLOOR COATING SHALL BE APPLIED AFTER EQUIPMENT INSTALLATION AND SHALL WRAP AROUND NEW CONCRETE CURBS AND PADS UP TO 6" TO EXISTING WALLS & COLUMNS. PROVIDE STANDARD COLOR, MEDIUM GRAY.
- $\frac{5}{A-4}$ PROVIDE FIRE DAMPER FRAMING AT NEW DUCT PENETRATIONS THROUGH METAL STUD & GYPSUM BD. PARTITION. SEE MECHANICAL WINGS AND DETAIL $\frac{5}{A-4}$
- $\frac{1}{A-4}$ WIDE NEW CABLE HOLE AS REQUIRED AT NEW WALL. CONTRACTOR VERIFY EXACT SIZE, LOCATION & QUANTITY. DETAIL $\frac{1}{A-4}$
- $\frac{2}{A-4}$ BLAST ENTIRE AREA OF WORK AS REQUIRED.
- $\frac{3}{A-4}$ EXISTING WIRE-MESH PARTITION TO REMAIN & PROTECTED DURING CONSTRUCTION.
- $\frac{4}{A-4}$ REMOVABLE RAMP, TYPICAL AT EACH SIDE OF NEW CONCRETE CURB. DETAIL $\frac{4}{A-4}$

- $\frac{10}{A-4}$ FILL ALL CONDUIT SLEEVE AT ALL NEW ELECTRICAL CONDUIT PENETRATIONS WITH FIRE STOPPING SEAL AS REQUIRED. SEE ELECTRICAL DRAWINGS.
- $\frac{11}{A-4}$ PROVIDE NEW 3-1/4" HIGH CURB TO BE PAINTED W/ YELLOW & BLACK STRIPES. SEE DETAIL $\frac{4}{A-4}$
- $\frac{12}{A-4}$ PROVIDE NEW 12" THICK CONCRETE PAD. SEE DETAIL $\frac{8}{A-4}$
- $\frac{13}{A-4}$ PROVIDE NEW 4" HIGH CONCRETE PAD. SEE DETAIL $\frac{3}{A-4}$
- $\frac{14}{A-4}$ EXISTING EQUIPMENT TO REMAIN & PROTECTED DURING CONSTRUCTION.
- $\frac{15}{A-4}$ NEW 3'-0" X 7'-0" X 1 3/4" METAL DOOR AND FRAME WITH 1-HOUR FIRE RATING WITH LEVER HARDWARE, BEST 7-PIN CORE LOCK AND DOOR CLOSER. PROVIDE DOOR HARDWARE TO MATCH EXISTING. SEE DETAIL $\frac{2}{A-4}$ $\frac{8}{A-4}$ SIM.
- $\frac{16}{A-4}$ PROVIDE NEW 15-1/2" X 34" X 4" HIGH CONCRETE PAD FOR NEW SWITCHBOARD. SEE DETAIL $\frac{16}{A-4}$

ROOM FINISH REFERENCE NOTES:

- $\frac{A}{A-4}$ PROVIDE PAINT TO BOTH SIDES OF NEW WALL & EXISTING WALL & COLUMNS TO MATCH EXISTING.
- $\frac{B}{A-4}$ PROVIDE TOP SET BASE TO NEW PARTITION TO MATCH EXISTING.
- $\frac{C}{A-4}$ PROVIDE PAINT TO BOTH SIDES OF NEW DOOR AND FRAME TO MATCH EXISTING.
- $\frac{D}{A-4}$ PROVIDE NEW PAINT TO EXISTING CONCRETE CEILING SLAB AND BEAMS TO MATCH EXISTING.

NOTES:
1. VENTILATION SHALL BE PROVIDED IN ACC.

BE INSTALLED IN SUCH AREAS AND SUPERVISED BY AN APPROVED CENTRAL, PROPRIETARY OR REMOTE STATION SERVICE OR A LOCAL ALARM WHICH WILL GIVE AN AUDIBLE SIGNAL AT A CONSTANTLY ATTENDED LOCATION. SEE ELEC. DWGS.

TELE/EQUIP SPACE


OFFICE SPACE

STORAGE SPACE

CIRCULATION/RESTROOMS/MISC SPACE

BASEMENT FLOOR PLAN - NEW WORK

CONSULTANT:

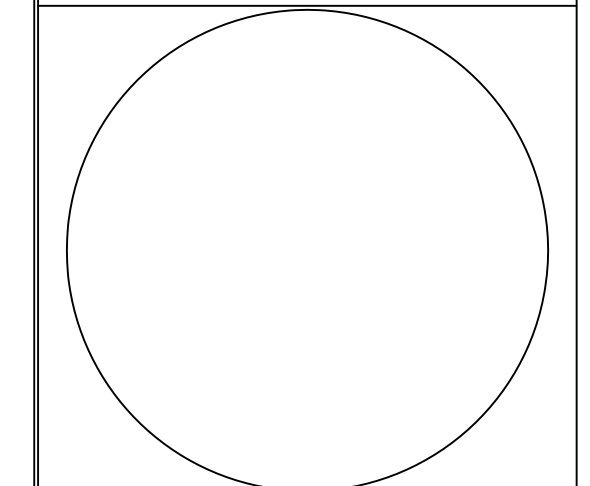

Allied Design Group Inc.
 HEADQUARTERS: 109 N. IVY AVE., SUITE C, MONROVIA, CA 91016
 GLENDALE OFFICE: 315 ARDEN AVENUE, #20, GLENDALE, CA 91201
 SAN DIEGO OFFICE: 2385 FOURTH AVENUE, SAN DIEGO, CA 92101

PROJECT NO. XXXXXX

PROJECT NO. 10320.0B

ISSUE DATE# 00-00-00
 DRWG# CLC##-##-YRMO
 SHT# A1, M1, S1 #####

REVISIONS / AUTHORIZATIONS			
NO.	REVISIONS / AUTHORIZATIONS	DATE	BY


PROPRIETARY PACIFIC BELL INFORMATION
 NOT FOR GENERAL USE OR DISCLOSURE OUTSIDE OF PACIFIC BELL UNDER EXEMPTIONS SET FORTH IN THE CALIFORNIA PUBLIC RECORDS ACT. THIS INFORMATION MAY ONLY BE USED BY AUTHORIZED PERSONNEL OF THE LOCAL GOVERNMENT AGENCY IN CONNECTION WITH APPLICATION FOR PERMITS AND AUTHORIZATIONS FOR BUILDINGS, CONSTRUCTION, AND/OR ZONING CHANGES.


DRAWINGS PREPARED FOR
PACIFIC BELL

PROJECT TITLE:
PDSCS INSTALLATION
 4480 KESTER AVE.
 SHERMAN OAKS, CA 91403
 SHOKKA01 B5109

SHEET TITLE:
**BASEMENT FLOOR PLAN
 NEW WORK**

ESTIMATE/ ROUTINE ORDER: B51117E	DATE: 1-8-01	SCALE: 3/32"=1'-0"
DRAWN BY: DS	CHECKED BY: JC	
PACIFIC BELL AUTHORIZATION:	SHEET: 4 OF: 5 SHEETS	BUILDING NO.
AUTHORIZATION SIGNATURE	PACIFIC BELL DRAWING NO.: SHOK01-10-0101-A3	268

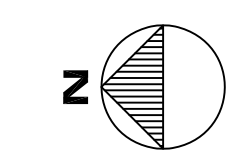


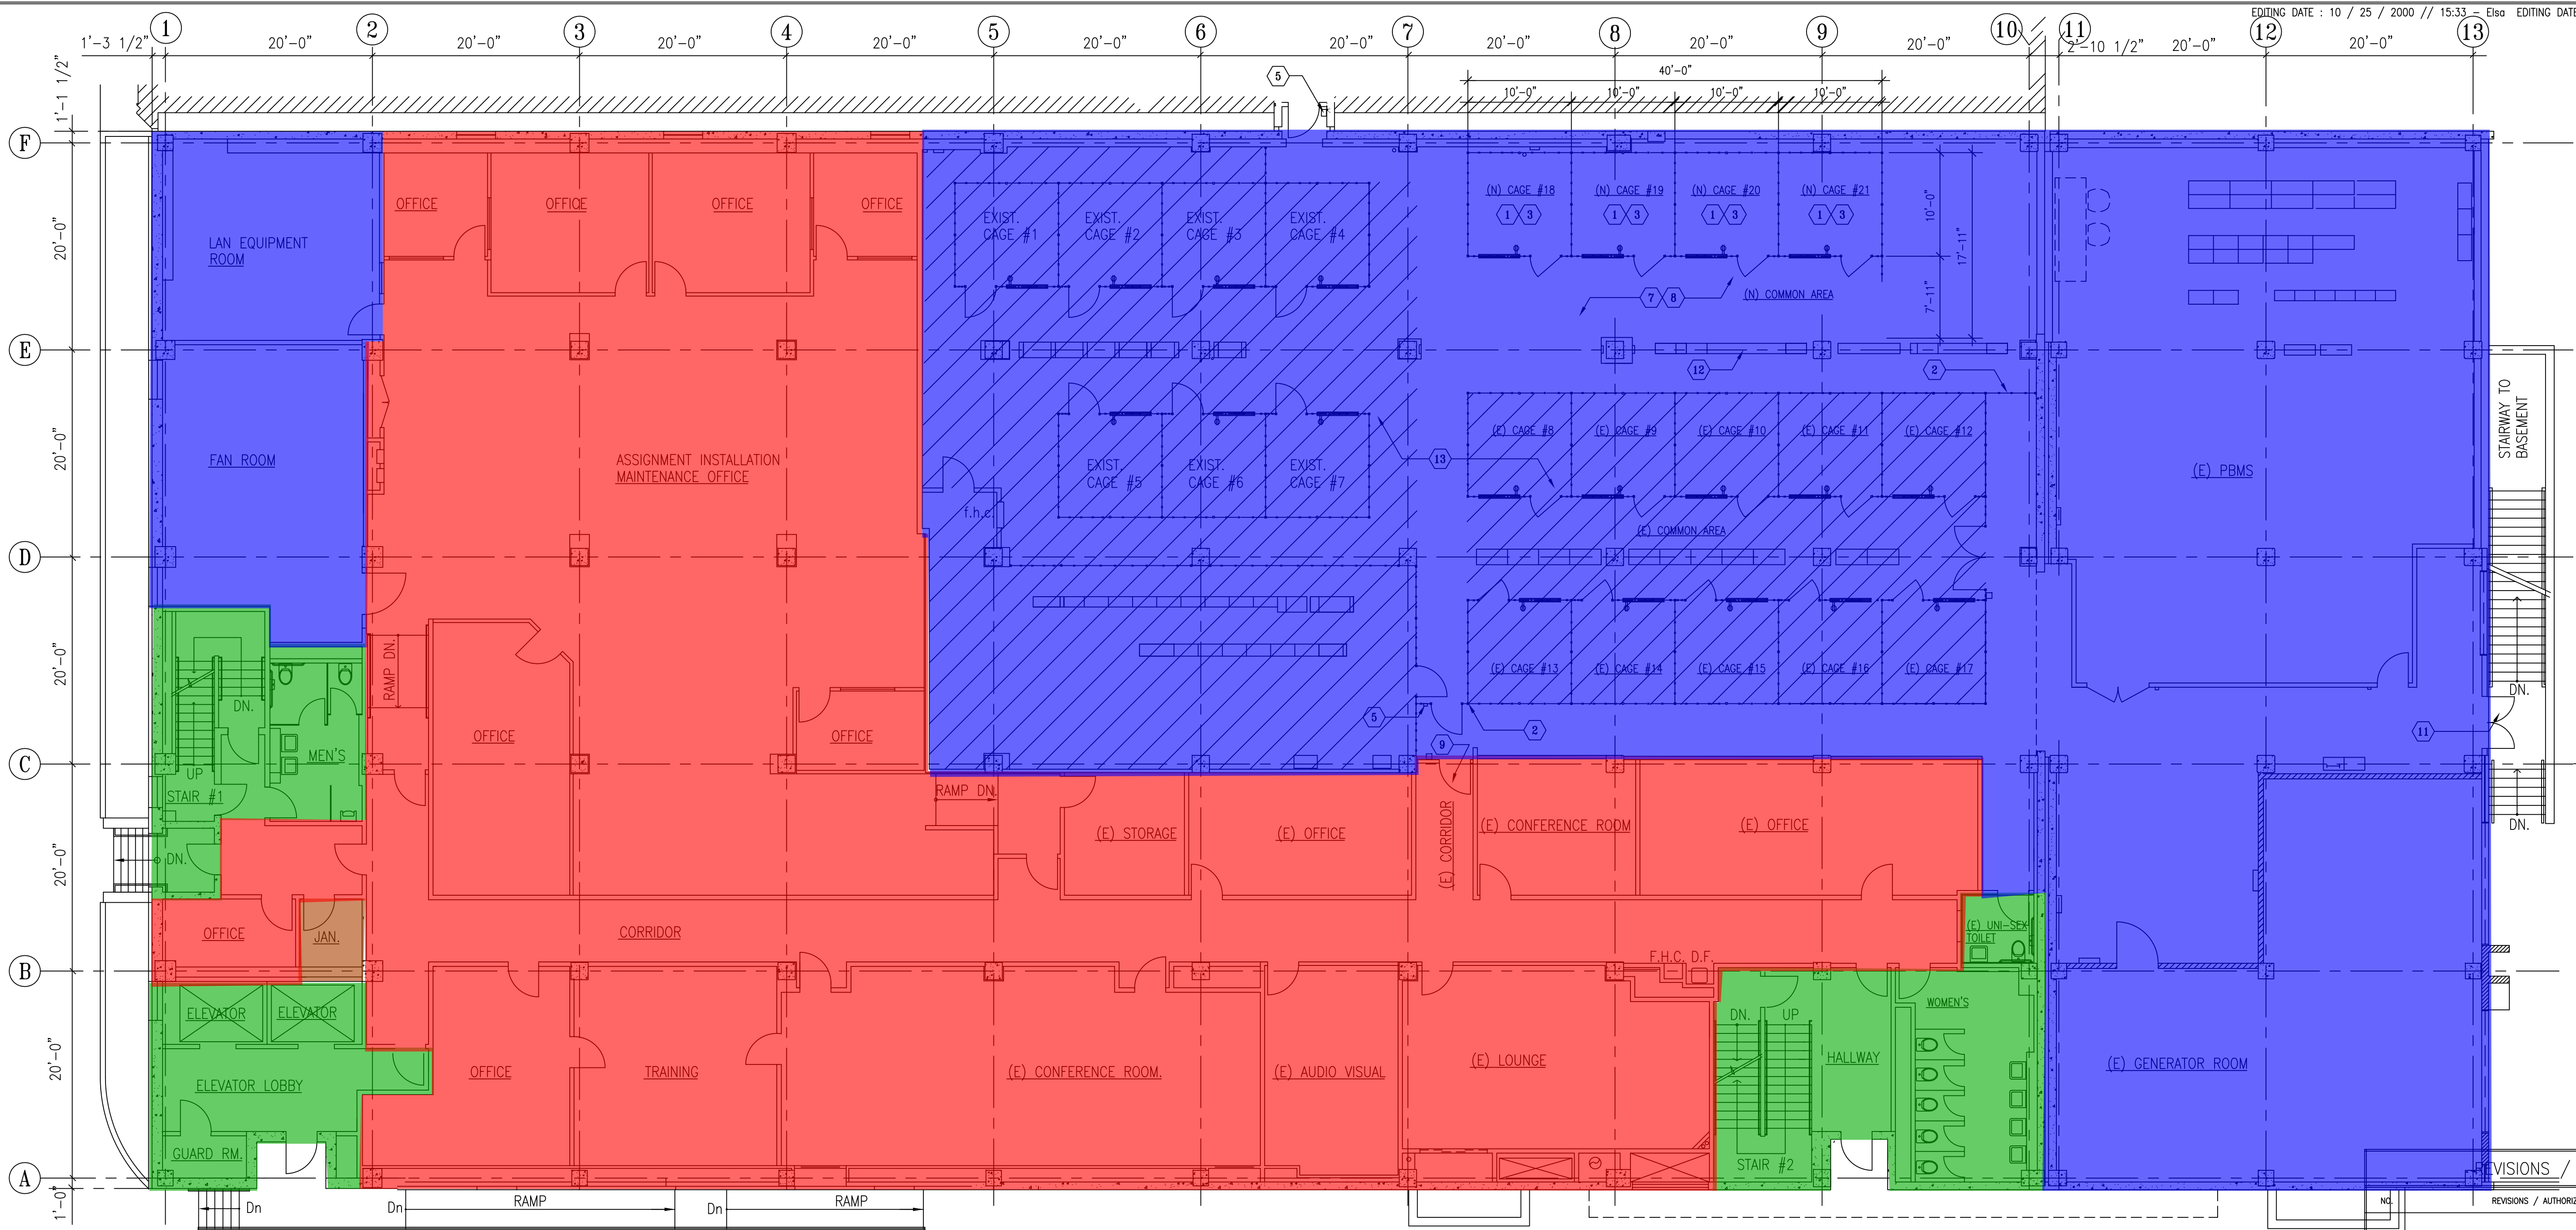


ISSUE DATE# 00-00-00
 DRWG# CLC##-##-YRMO
 SHT# A1, M1, S1 #####
 ISSUE DATE# 00-00-00
 DRWG# CLC##-##-YRMO
 SHT# A1, M1, S1 #####

REFERENCE NOTES:

- 1 PROVIDE 10'-0" X 10'-0" X 9'-0" HIGH WIRE-MESH CAGE WALL TO CONSIST OF 5'-0" WIDE PANELS. THE PANELS BETWEEN CAGES MUST BE REMOVABLE WITHOUT DISTURBING THE PERIMETER WALLS OR ROOF PANELS. SEE DETAIL 9/A-2
- 2 NEW WIRE-MESH PARTITION FROM FINISH FLOOR TO UNDERSIDE OF CONCRETE CEILING SLAB, TYPICAL AT PERIMETER.
- 3 NEW WIRE-MESH CEILING PANELS AT EACH EQUIPMENT CAGE. SEE DETAIL 15/A-2
- 4 NOT USED
- 5 NEW CARD READER ACCESS PER PACIFIC BELL STANDARD.
- 6 NOT USED
- 7 EXISTING FLOORING TO REMAIN PATCH AND REPAIR AS REQUIRED.
- 8 (N.I.C.) NEW TELEPHONE EQUIPMENT.
- 9 EXISTING DOOR WITH CARD READER ACCESS TO REMAIN.
- 10 NOT USED
- 11 EXISTING EXIT DOOR SHALL BE OPENABLE FROM THE INSIDE WITHOUT THE USE OF A KEY OR ANY SPECIAL KNOWLEDGE OR EFFORT (91.1004.3) AT ALL TIMES.
- 12 EXISTING CABLE FLOOR ACCESS TO REMAIN.
- 13 EXISTING WIRE-MESH PARTITION SYSTEM AND TELEPHONE EQUIPMENT WITHIN HATCHED AREA TO REMAIN.

NOTE:
 THIS PACIFIC BELL BUILDING STRUCTURE WAS DESIGNED TO ACCOMMODATE A LOAD OF 150 LBS/SQ. FT.. ALL NEW TELEPHONE EQUIPMENT TO BE PLACED IN CAGES FOR THESE COLLOCATION VENDORS WEIGHS APPROXIMATELY 50 LBS/SQ.FT. AND WILL NOT EXCEED THE DESIGN LOAD OF 150 LBS/SQ.FT..

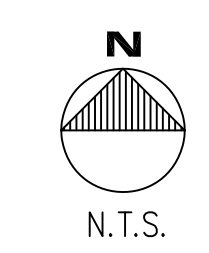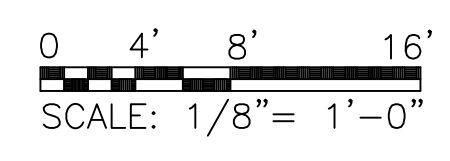


JTC architects, inc.
 109 NORTH IVY AVENUE, SUITE C, MONROVIA, CA 91016
 TEL: 626-357-3974 FAX: 626-301-9767 EMAIL: jtcarch@jtc.net

NO.	REVISIONS / AUTHORIZATIONS	DATE	BY

PROPRIETARY PACIFIC BELL INFORMATION
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DRAWINGS PREPARED FOR
PACIFIC BELL
 PROJECT TITLE:
CO-LOCATION - 2000
 4480 KESTER AVENUE,
 SHERMAN OAKS, CALIFORNIA 94103
 SHOKCA01 85109

SHEET TITLE:
**FIRST FLOOR PLAN
 NEW WORK**
 ESTIMATE/ ROUTINE ORDER: B 51111 E DATE: 04-25-00 SCALE: AS SHOWN
 DRAWN BY: CSS CHECKED BY: CSS
 PACIFIC BELL AUTHORIZATION: SHEET: 2 OF: 3 SHEETS SHEET NO.
 PACIFIC BELL DRAWING NO.: SHOK01-05-0400-T1 268
 AUTHORIZATION SIGNATURE

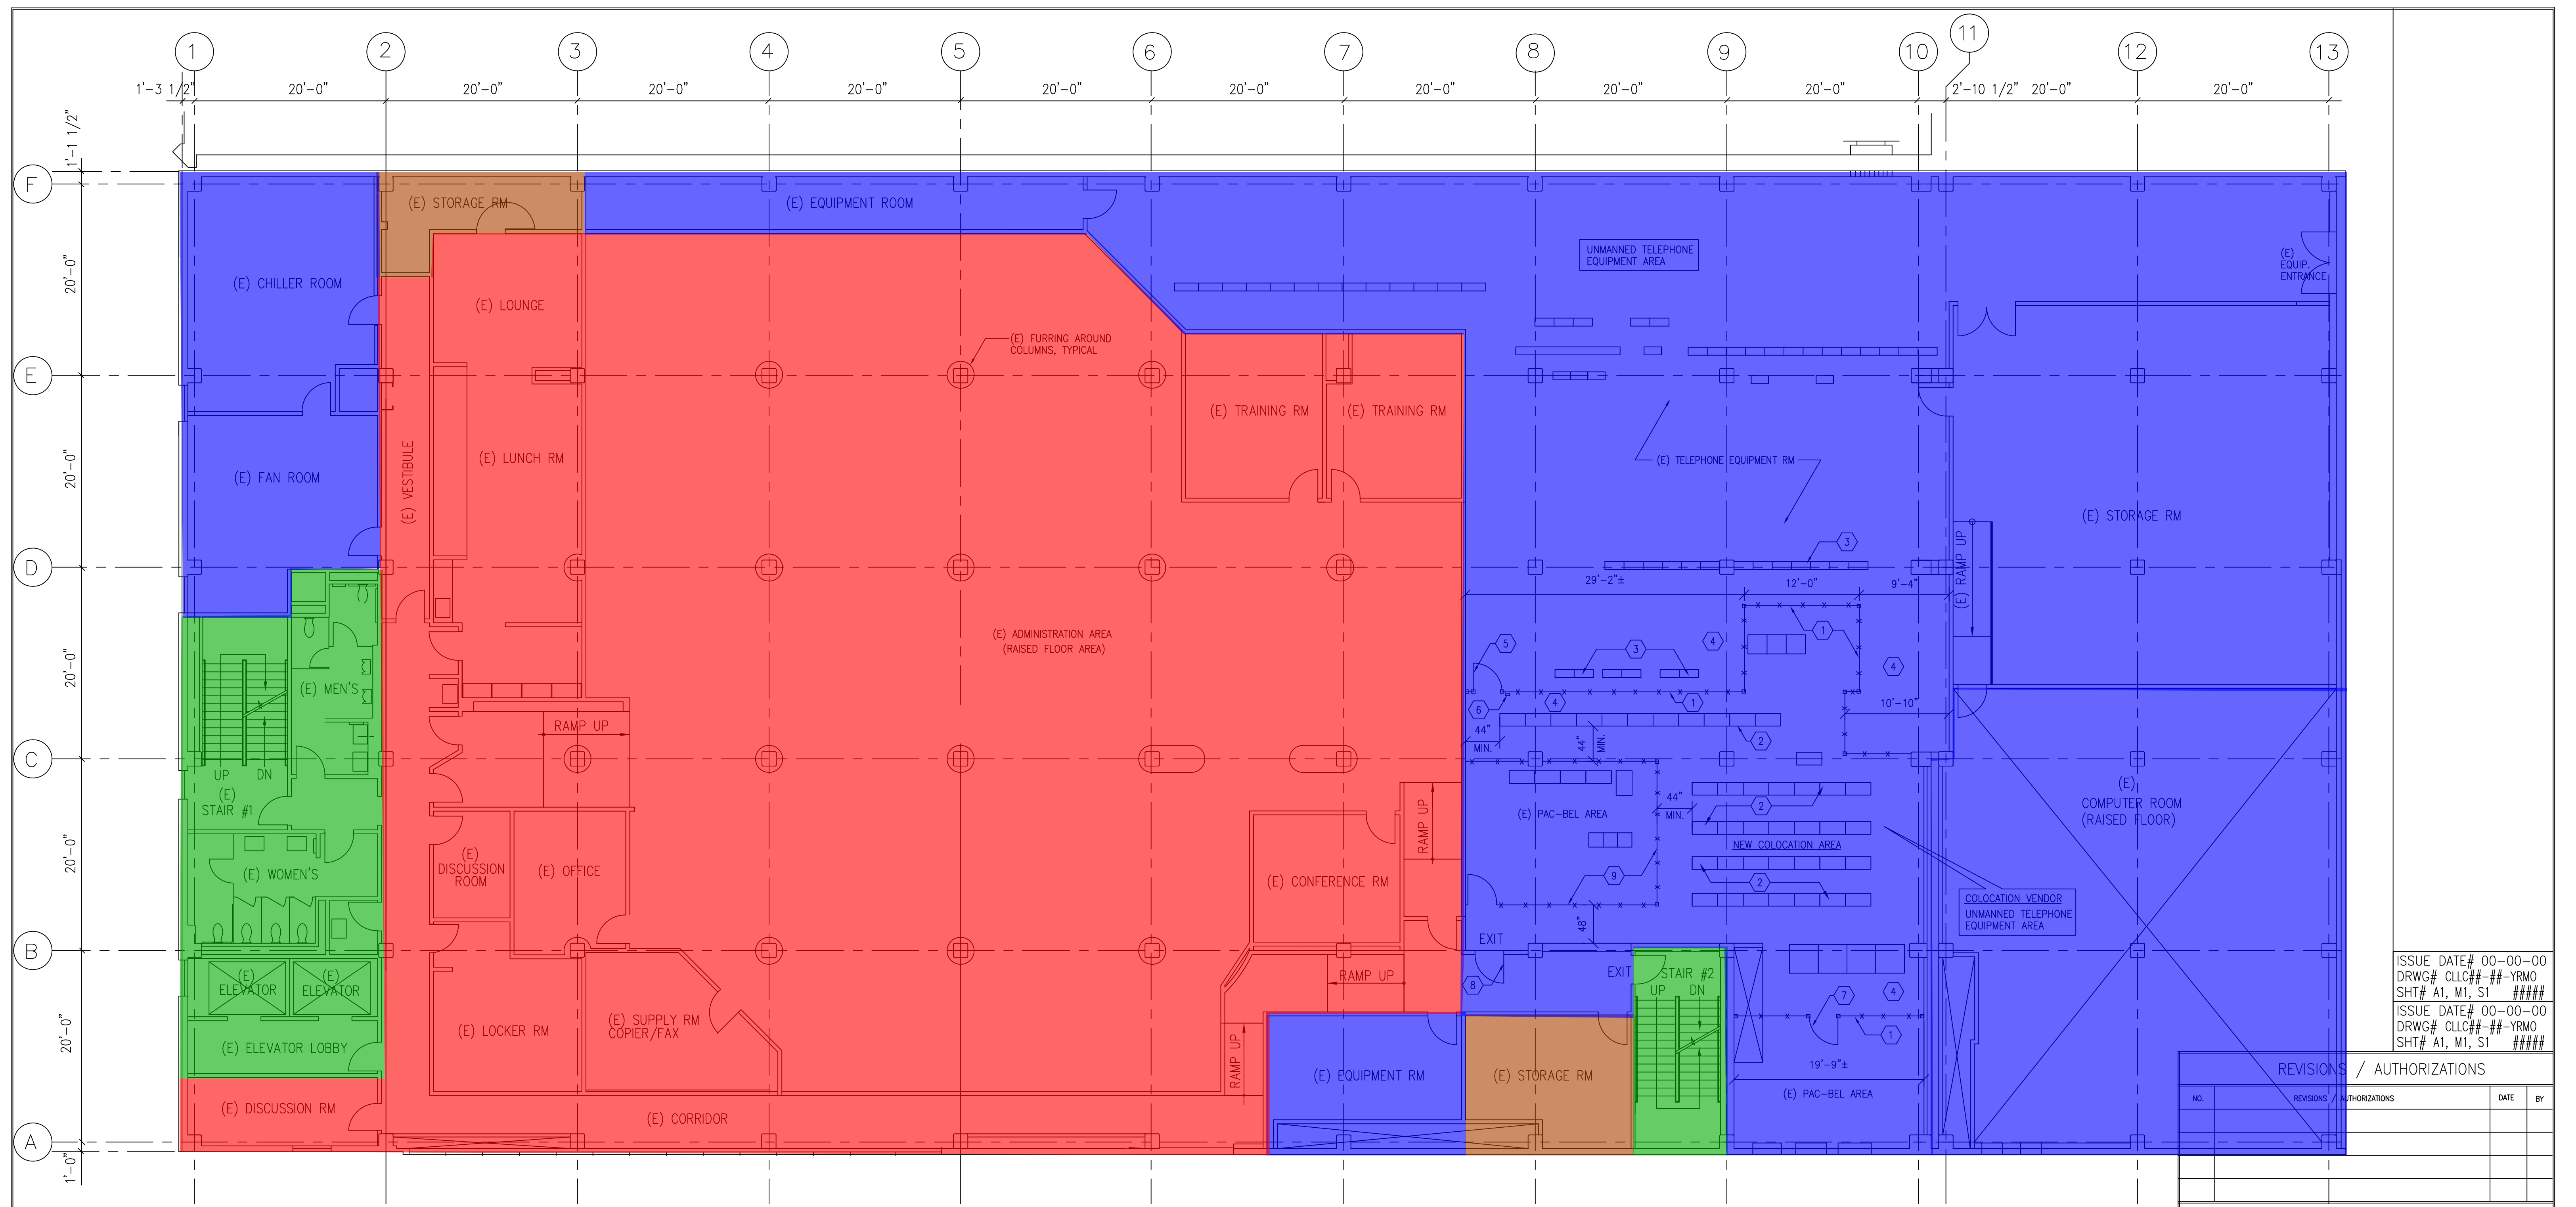

ISSUE DATE# 00-00-00
 DRWG# CLLC##-##-YRMO
 SHT# A1, M1, S1 #####
 ISSUE DATE# 00-00-00
 DRWG# CLLC##-##-YRMO
 SHT# A1, M1, S1 #####

REVISIONS / AUTHORIZATIONS			
NO.	REVISIONS / AUTHORIZATIONS	DATE	BY

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 THE LOCAL GOVERNMENT AGENCY IN CONNECTION WITH APPLICATION FOR
 PERMITS AND AUTHORIZATIONS FOR BUILDINGS, CONSTRUCTION, AND/OR
 ZONING CHANGES.

DRAWINGS PREPARED FOR
PACIFIC BELL
 PROJECT TITLE:
CO-LOCATION - 2000
 4480 KESTER AVENUE,
 SHERMAN OAKS, CALIFORNIA 94103
 SHOKCA01 B5109

SHEET TITLE:
**THIRD FLOOR PLAN
 NEW WORK**
 ESTIMATE/ ROUTINE ORDER:
B 51111 E
 DATE: 1-9-01 SCALE: AS SHOWN
 DRAWN BY: BZ CHECKED BY: DS
 PACIFIC BELL AUTHORIZATION:
 SHEET: 2 OF: 3 SHEETS SHEET NO.
 PACIFIC BELL DRAWING NO.:
 SHOK01-08-0900-A1 268
 AUTHORIZATION SIGNATURE

JTC architects, inc.
 109 NORTH IVY AVENUE, SUITE C, MONROVIA, CA 91016
 TEL: 626-357-3974 FAX: 626-301-9767 EMAIL: jtcarch@jtc.net

PROJECT NO. 81835.3A

REFERENCE NOTES:

- ① NEW 8'-0" HIGH WIRE-MESH PARTITION TO MATCH EXISTING. SEE DETAIL 9 A-7 SIM.
- ② (N.L.C.) NEW TELEPHONE EQUIPMENT
- ③ EXISTING EQUIPMENT TO REMAIN AND PROTECTED DURING CONSTRUCTION.
- ④ PATCH & REPAIR EXISTING FLOORING AS REQUIRED TO MATCH EXISTING WITHIN THE AREA OF EXISTING & NEW WORK.
- ⑤ NEW 3'-0" x 7'-0" WIRE-MESH GATE WITH LEVER HARDWARE, ELECTRIC STRIKE, BEST 7-PIN CORE LOCK AND DOOR CLOSER.
- ⑥ NEW CARD READER ACCESS PER PACIFIC BELL STANDARD.
- ⑦ NEW 3'-0" x 7'-0" WIRE-MESH GATE WITH LEVER HARDWARE, "UNICAN" LOCK, BEST 7-PIN CORE LOCK & DOOR CLOSER.
- ⑧ EXISTING DOOR WITH "UNICAN LOCK" AT CORRIDOR SIDE TO REMAIN. EXIT AT COLOCATION SIDE.
- ⑨ EXISTING WIRE-MESH PARTITION TO REMAIN & PROTECTED DURING CONSTRUCTION.

LEGEND:

- x — x — x — NEW STANDARD HEAVY DUTY WIRE-MESH PARTITIONS BY CALIFORNIA WIRE PRODUCTS CORPORATION, PHONE # (714) 371-7730 OR KING WIRE PARTITIONS, INC. PHONE # (323) 256-4848
- — — — — EXISTING CONSTRUCTION TO REMAIN.

NOTE:
 ALL EXIT DOORS SHALL BE OPENABLE FROM THE INSIDE WITHOUT THE USE OF A KEY OR ANY SPECIAL KNOWLEDGE OR EFFORT.

NOTE:
 THIS PACIFIC BELL BUILDING STRUCTURE WAS DESIGNED TO ACCOMMODATE A LOAD OF 150 LBS/SQ.FT. ALL NEW TELEPHONE EQUIPMENT TO BE PLACED IN CAGES FOR THESE CO-LOCATION VENDORS WEIGHS APPROX. 50 LBS/SQ.FT. AND WILL NOT EXCEED THE DESIGN LOAD OF 150 LBS/SQ.FT.


NOTE:

This project consists of modifying existing building spaces for installing wire-mesh cages within an existing telecommunication equipment area. These cages will be used to house telecommunication equipment owned by other service providers who intend to provide telecommunication services in the area. The equipment is unmanned and requires only periodical maintenance once it is installed and in operation. Persons who use wheelchair for mobility are not suitable to perform the required maintenance work because the nature of work would often require pulling cables, climbing ladders and lifting of heavy materials. In accordance with Title 24, Section 1105B.3.4.2, Exception 1, this type of public utility facility is not subject to the wheelchair accessibility requirements.

PLOTING SCALE: 1/1
 DATE:
 FILE:

THIRD FLOOR PLAN - NEW WORK



1/8"=1'-0" 8

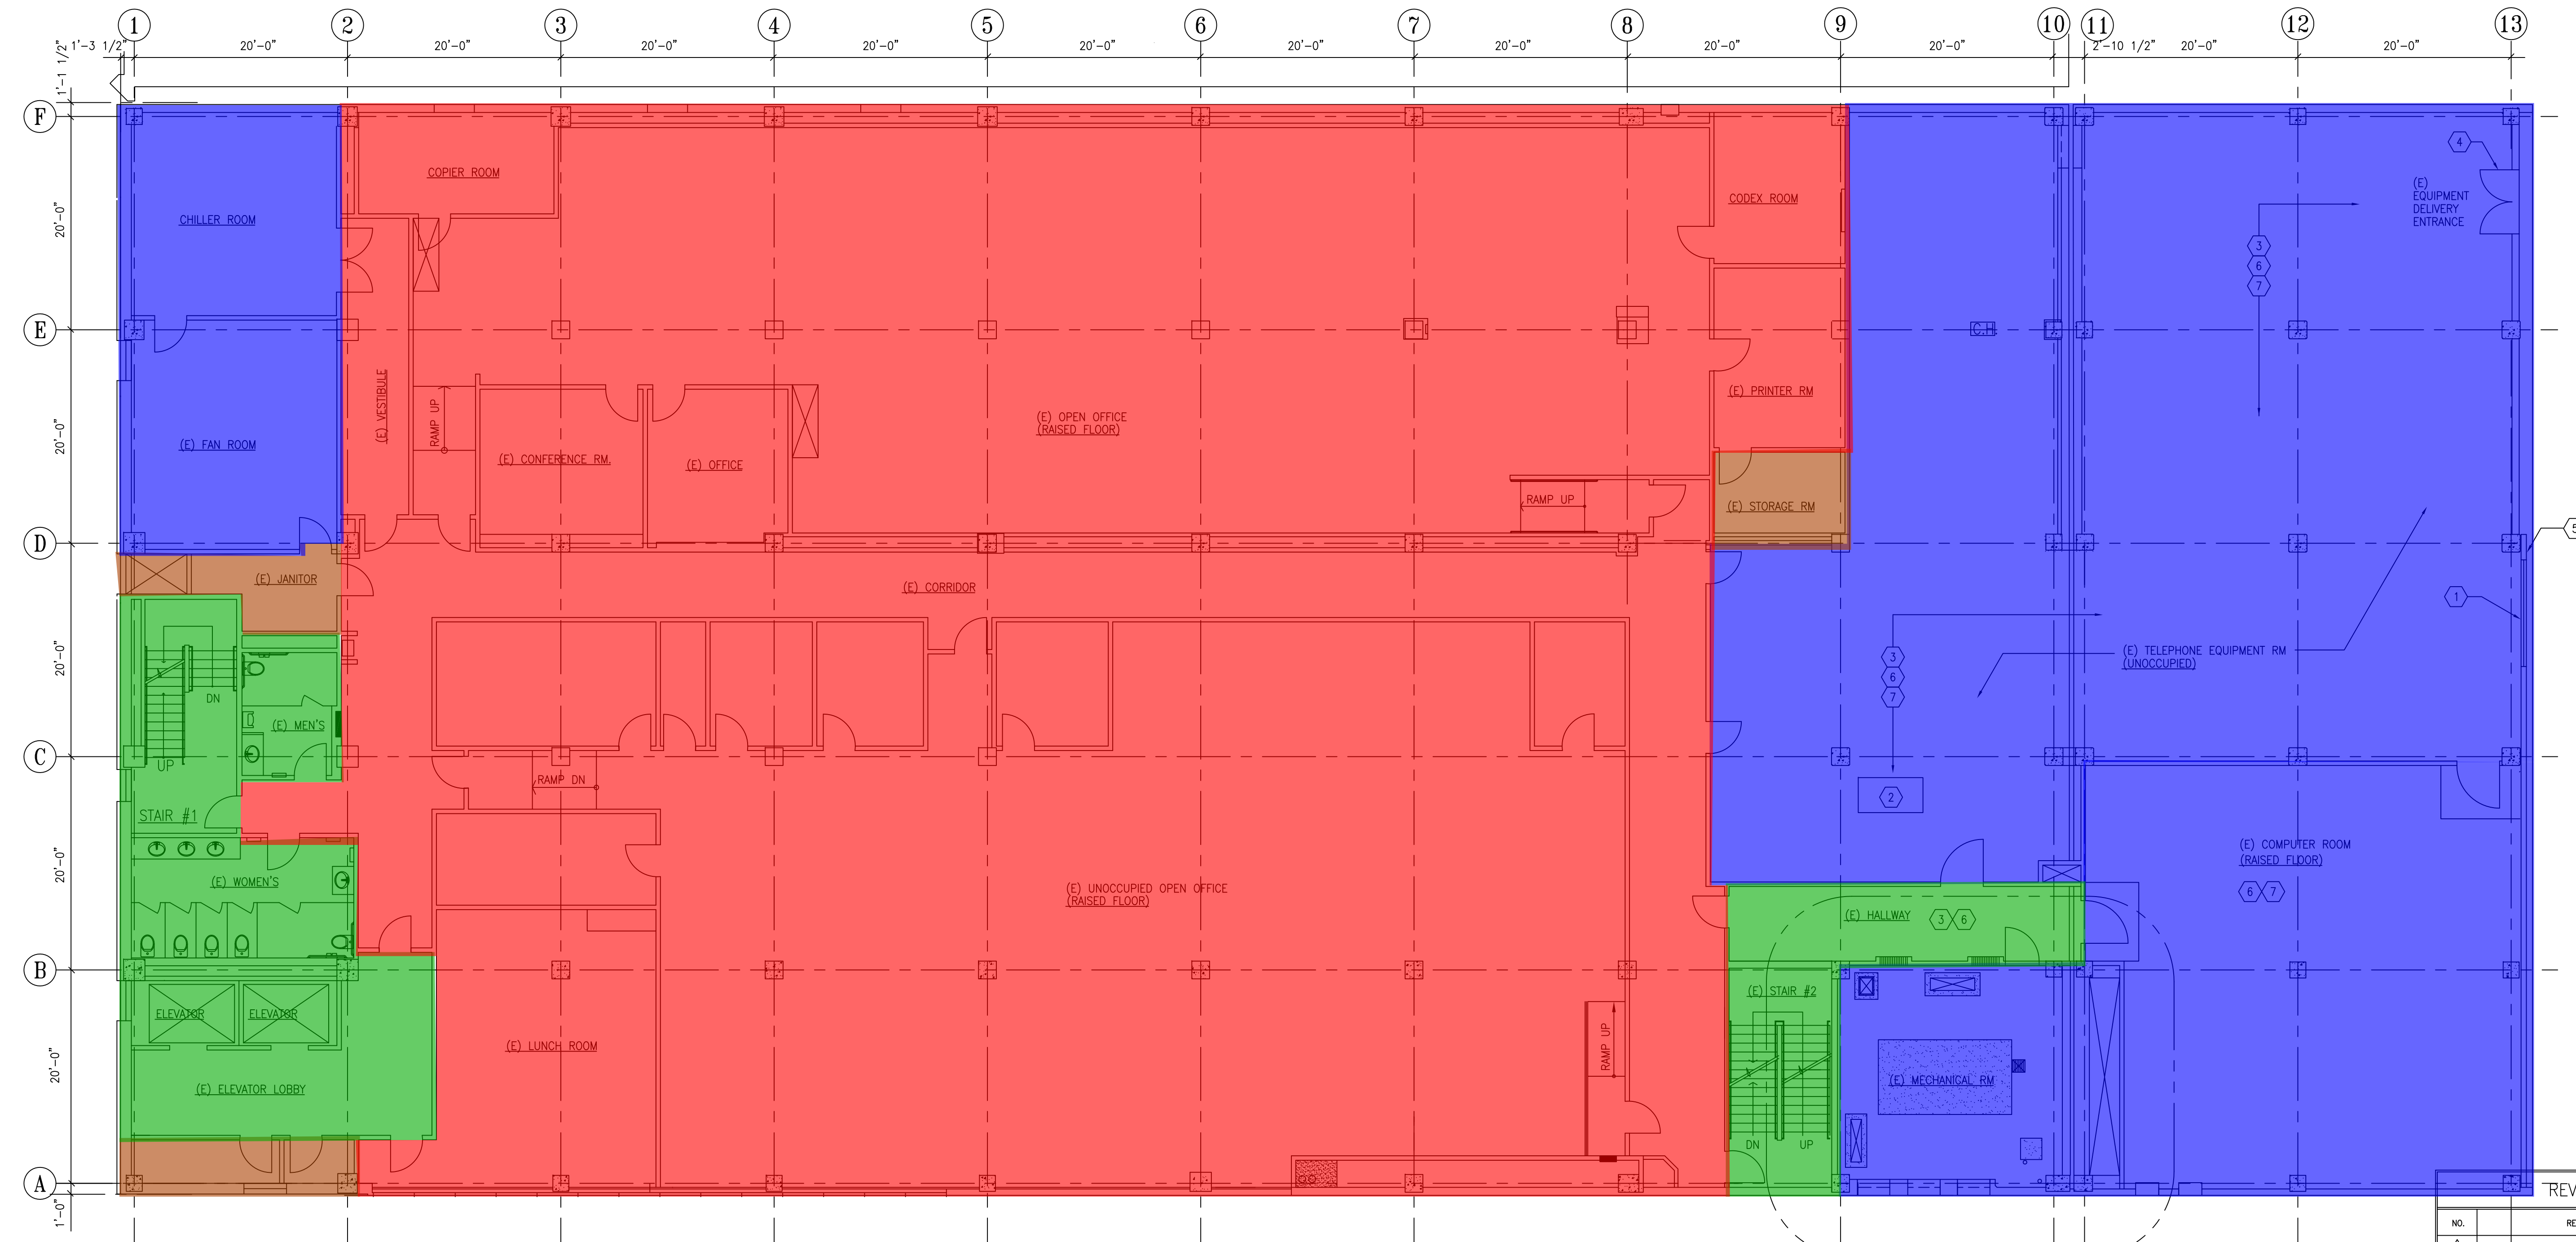

- REFERENCE NOTES:**
- ① EXISTING 10'-0" WIDE X 4'-0" HIGH STEEL LOUVERS TO REMAIN.
 - ② REFER TO MECHANICAL, PLUMBING AND ELECTRICAL DEMOLITION DRAWINGS FOR WORK AT THIS AREA.
 - ③ CONTRACTOR TO IDENTIFY EQUIPMENT DELIVERY PATH OF TRAVEL AND PROTECT EXISTING FLOORING DURING TRANSPORTATION OF NEW TEMPORARILY EQUIPMENT UNIT OR CONSTRUCTION MATERIALS.
 - ④ EXISTING EQUIPMENT DELIVERY ENTRANCE TO REMAIN AND PROTECTED. CONTRACTOR SHALL BE RESPONSIBLE TO REPAIR DAMAGES THAT OCCUR DURING CONSTRUCTION.
 - ⑤ EXISTING EXTERIOR WALL WITH METAL LATH AND PLASTER TO REMAIN.
 - ⑥ EXISTING FLOOR FINISH TO REMAIN. PATCH AND REPAIR DAMAGES FROM CONSTRUCTION AS REQUIRED.
 - ⑦ PROVIDE ADEQUATE PROTECTION TO EXISTING FLOORING AND ALL NEARBY EQUIPMENT AND STRUCTURE.

GENERAL NOTES:

1. AFTER THE END OF EACH WORK SHIFT, ALL MATERIAL AND EQUIPMENT SHALL BE PROPERLY COVERED AND SECURED WITH PACIFIC BELL APPROVED ANTI-STATIC/FIRE RETARDANT TARPS, AS MANUFACTURED BY REEF INDUSTRIES, (800) 231-6074, MIKE MC ELHANY OR CAMERON & BARKLEY, (919) 834-6010, MIKE GARDNER.

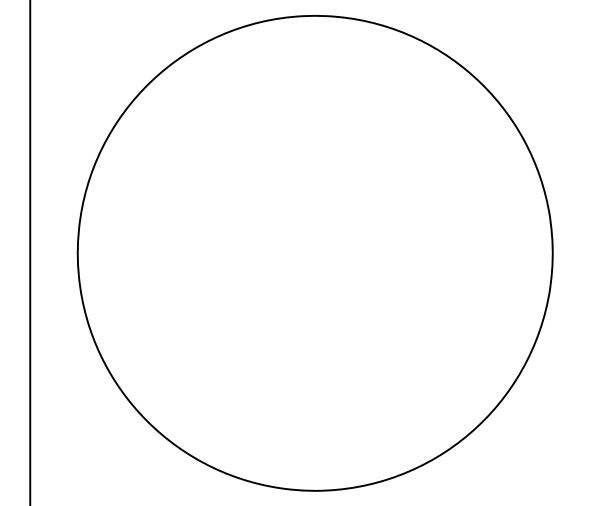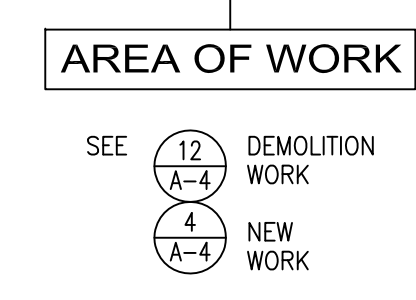

PROJECT NO. 20345.0B

Med Design Group Inc.
 HEADQUARTERS: 65 N. FIRST AVE., SUITE 201, ARCATA, CA 95521
 OLYMPIA OFFICE: 1100 11TH ST., SUITE 100, OLYMPIA, WA 98513
 SEASIDE OFFICE: 1000 11TH AVE., SUITE 201, SEASIDE, CA 95732
 SAN DIEGO OFFICE: 2300 LA JOLLA VILLAGE, SAN DIEGO, CA 92161
 TEL: 530-244-8884 FAX: 530-274-7775
 TEL: 619-235-8777 FAX: 619-237-0541

REVISIONS / AUTHORIZATIONS

NO.	REVISIONS / AUTHORIZATIONS	DATE	BY
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DRAWINGS PREPARED FOR
PACIFIC BELL SERVICES, INC.

PROJECT TITLE:
AIR HANDLER REPLACEMENT (#408)
 4480 KESTER AVENUE,
 SHERMAN OAKS, CA 91403

SHOKCA01 B5109

SHEET TITLE:
EXISTING FOURTH FLOOR PLAN - SHOWING AREA OF WORK

ESTIMATE/ ROUTINE ORDER: B51121E	DATE: 5-8-03	SCALE: A.S.
DRAWN BY: CSS	CHECKED BY: JC	
PACIFIC BELL AUTHORIZATION:	SHEET: 3 OF: 5 SHEETS	BUILDING NO.
	SHOK01-02-1102-A3	268



1/8"=1'-0" 4

EXISTING FOURTH FLOOR PLAN - SHOWING AREA OF WORK